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LINAC - GROUND FLOOR - DOOR SCHEDULE

TAG	WIDTH	HEIGHT	COUNT
AD14p	2000	2400	3
AD16p	1500	2400	1
FD06	1200	2100	1
FD09	900	2100	1
LD02a	1500	2100	1
SD10	750	2000	1
WD06a	2000	2300	4
WD09a	1500	2300	1
WD09v	1500	2100	3
WD11Lv	1000	2100	2

LINAC - GROUND FLOOR - WINDOW SCHEDULE

TAG	WIDTH	HEIGHT	COUNT
WD17	850	2100	9
WD17L	850	2100	1
WD19	1050	2100	2
WD19v	1050	2100	1
WD19v1	1050	2300	2

LINAC - GROUND FLOOR - WINDOW SCHEDULE

TAG	WIDTH	HEIGHT	SILL	COUNT
AW01	1800	1500	900	10
LW01	1200	1200	900	1

SHAFT SCHEDULE FOR GF FLOOR (L)

TAG	DESCRIPTION	LENGTH	WIDTH
00-SH-301	ELECTRICAL SHAFT	300	300
00-SH-401	FEA	300	300

<u>LEGEND :</u>		AHU	AIR HANDLING UNIT
FRL	FINISHED ROAD LEVEL	LD	LEAD LINED DOOR
FGL	FORMED GROUND LEVEL	AL	ALUMINIUM LOUVER
FFL	FINISHED FLOOR LEVEL	AW	ALUMINIUM WINDOW
FEA	FIRE EQUIPMENT AREA	AD	ALUMINIUM DOOR
TOC	TOP OF CONCRETE	WD	WOODEN DOOR
LVL	LEVEL	FD	FIRE DOOR
TOI	TOILET	RSO	RADIATION SAFETY OFFICER
ELV	EXTRA LOW VOLTAGE	TPS	TREATMENT PLANNING STATION
PHE	PUBLIC HEALTH ENGINEERING	CT	COMPUTER TOMOGRAPHY
HVAC	HEATING VENTILATION AIR CONDITIONING	FPL	FINISHED PAVER BLOCK
		NS	NURSE STATION

- WALL LEGEND :**
- 250MM THK. BLOCK WALLS UP TO SOFFIT OF THE SLAB/B.EAM.
 - 230MM THK BRICK WORK UP TO SOFFIT OF THE SLAB/B.EAM.
 - 115MM THK BRICK WORK UP TO SOFFIT OF THE SLAB/B.EAM.
 - 75MM THK. DRY TO DRY WALL PARTITION From TOC to 100mm High TOP OF THE FALSE CEILING.
 - 75MM THK. DRY TO WET WALL PARTITION From TOC to 100mm High TOP OF THE FALSE CEILING.
 - 200MM THK. DRY TO DRY WALL PARTITION From TOC to 100mm High TOP OF THE FALSE CEILING.
 - 125MM THK. DRY TO DRY WALL PARTITION (FIRATED) UP TO SOFFIT OF THE SLAB/B.EAM.
 - 125MM THK. DRY TO WET WALL PARTITION UP TO SOFFIT OF THE SLAB/B.EAM.
 - 125MM THK. DRY TO DRY WALL PARTITION UP TO SOFFIT OF THE SLAB/B.EAM.
- KEY NOTES :**
- 500MM WIDE SUNSHADE PROJECTION ABOVE.
 - 600MM WIDE PLINTH PROTECTION.
 - RAIN WATER DOWN TAKE PIPE.
 - 600MM WIDE COUNTER TO DETAIL.
 - 150MM THK. 150MM HIGH KERB WALL.
 - MAN HOLE REFER STRUCTURAL DRAWING.
 - TRENCH DETAIL REFER STRUCTURAL DRAWING.
 9. ELECTRICAL DB LOCATION.
 10. COVER FOR SUMP AS PER STRUCTURAL DETAIL.
 11. 1000 MM HIGH MS HANDRAIL.
 12. 600 MM WIDE SUNSHADE PROJECTION ABOVE.

1	0006
2	0006
3	0006
4	0006
5	0006
6	0006
7	0006
8	0006
9	0006
10	0006
11	0006
12	0006

CLIENT : ASSAM CANCER CARE FOUNDATION

L&T Construction
Buildings & Factories

PROJECT : Proposed Cancer Centre At 18 Locations In Assam For Assam Cancer Care Foundation & M/s. Tata Trusts

CONSULTANT : Engineering Design and Research Center (EDRC), L&T Construction - Buildings & Factories.

JORHAT CANCER CENTRE
(A Government of Assam and Tata Trusts Initiative).

CONCEPT : Engineering Design and Research Center (EDRC), L&T Construction - Buildings & Factories.

ARCHITECT : L&T Construction - Buildings & Factories.


SUPPLIER / CONTRACTOR : Larsen & Toubro Limited, Construction, Buildings & Factories

N		DATE	<div><div></div><div>ELEVATION MARKING</div><div>DRAWING NUMBER</div><div>SCALE As indicated</div></div>
		20.11.19	
		20.11.19	
		21.11.19	
		27.11.19	
TITLE			
LINAC BLOCK			
GROUND FLOOR PLAN			
PROJECTION			235

DRAWING No. **O19035 - A - HP - 12 - WD - 0001**

SHEET: 1 of 1

RELEASED FOR ☐ PRELIMINARY ☐ TENDER ☐ INFORMATION ☐ APPROVAL ☒ CONSTRUCTION

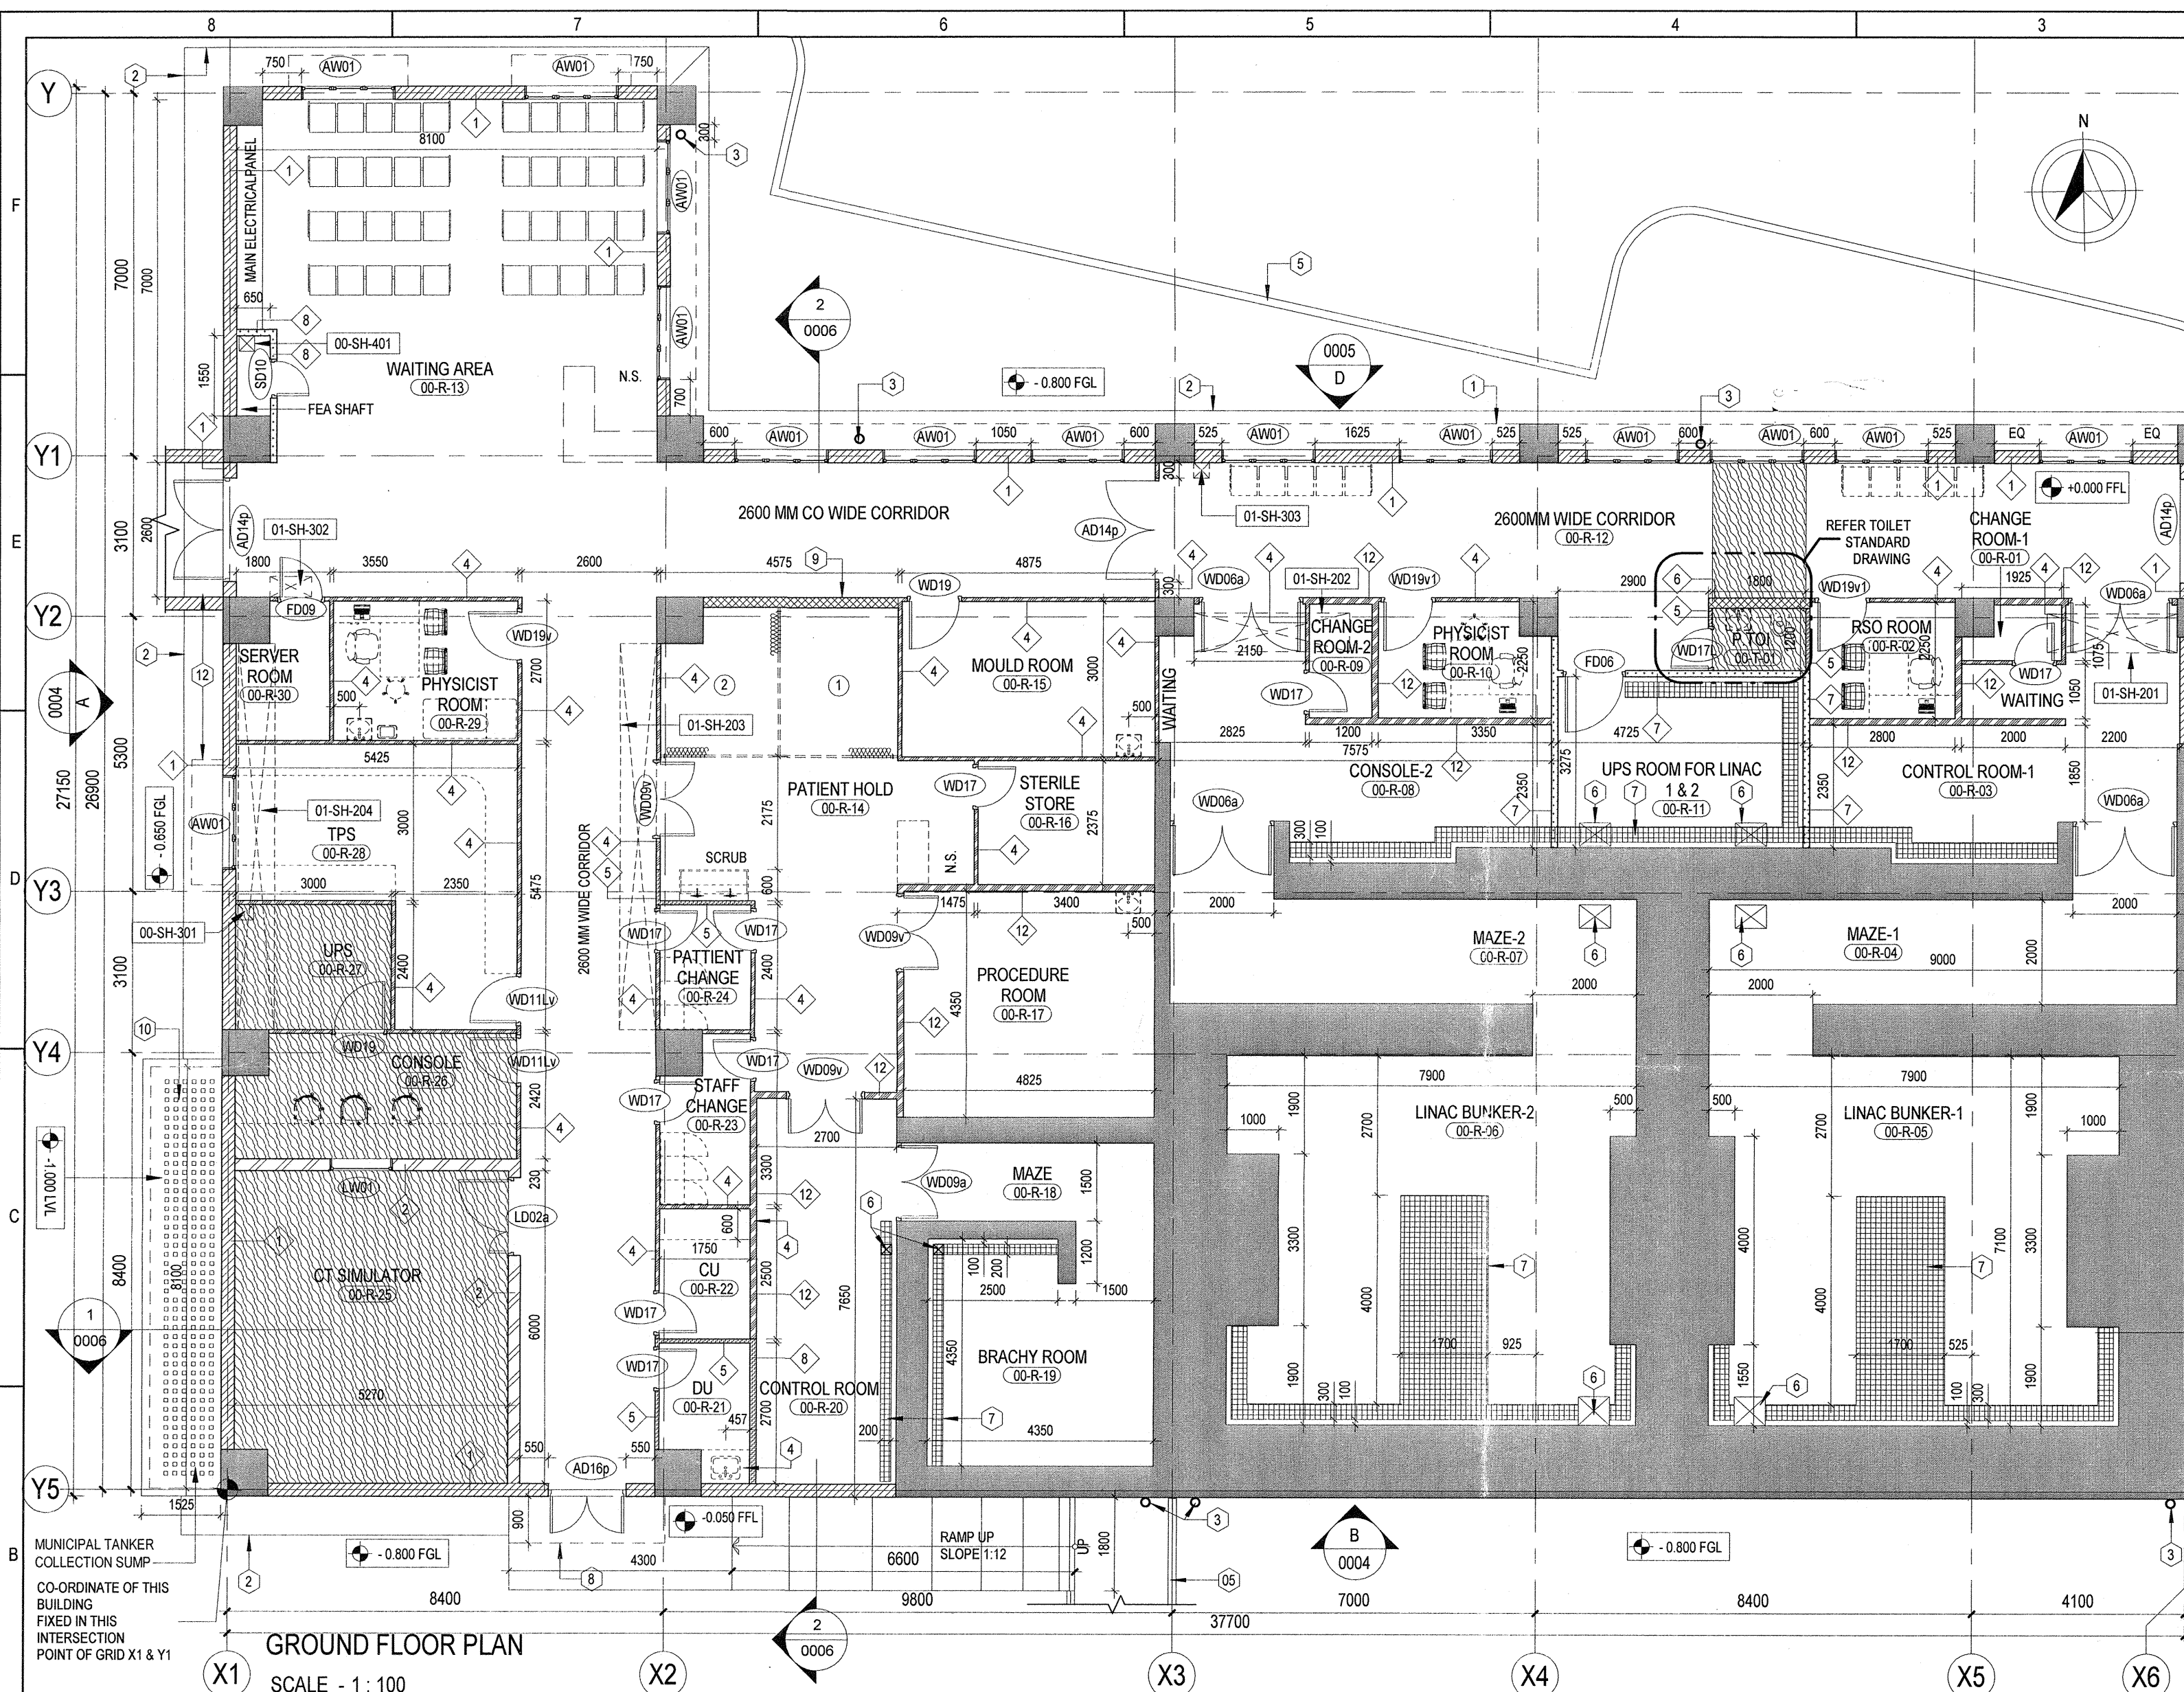

GROUND FLOOR PLAN

SCALE - 1 : 100

- GENERAL NOTES :**
01. ALL DIMENSIONS ARE IN MILLIMETERS & LEVELS IN METERS.
 02. THIS DRAWING SHOULD BE READ IN CONJUNCTION WITH THE FOLLOWING DRAWINGS O19035-A-HP-12-WD-0002 TO 0005.
 03. FOR JOINERY, STAIRCASE, RAMP DETAILS, LIFTS, TOILETS, WALL SECTIONS, FLOORING PATTERN DETAILS & FALSE CEILING DETAILS REFER SEPARATE DRAWINGS.
 04. FOR STRUCTURAL, PUBLIC HEALTH ENGINEERING, HVAC, ELECTRICAL, AND FIRE FIGHTING DETAILS REFER APPROPRIATE SEPARATE DRAWINGS.
 05. ALL EXTERNAL WALLS SHOULD BE BUILT UPTO SOFFIT OF BEAM OR CEILING.
 06. ANY DISCREPANCIES NOTICED IN THIS DRAWING SHOULD BE BROUGHT TO EDRC'S NOTICE IMMEDIATELY.
 07. ALL ROOF SLAB CUTOUPS INDICATED IN THIS DRAWING ARE TENTATIVE. REFER STRUCTURAL DRAWINGS FOR EXACT LOCATION.
 08. +0.000FFL REFERS TO +100.600 LEVEL AT SITE.
 09. FURNITURE SHOWN IF ANY ARE INDICATIVE ONLY AND NOT IN L&T SCOPE.

SUNKEN LEGEND:

200MM SUNKEN FROM FFL

CLIENT SIGNATURE :

0	RELEASED AS GOOD FOR CONSTRUCTION	ARKH	20.11.19	SSV	20.11.19	TI	21.11.19	JA	27.11.19
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REV.NO.	DESCRIPTION	DESIGNED	DRAWN	CHECKED	APPROVED
0	RELEASED AS GOOD FOR CONSTRUCTION	ARKH	20.11.19	SSV	20.11.19



CHECKED BY	SIGN	DATE	CHECKED BY	SIGN	DATE	CHECKED BY	SIGN	DATE
ARCHITECTURE		27/11/19	HVAC		27/11/19	GIS		27/11/19
CIVIL & STRUCTURAL		27/11/19	FPS		27/11/19	GEOTECH		27/11/19
ELECTRICAL		27/11/19	PIPING		27/11/19	VHT		27/11/19
ELV SYSTEM		27/11/19	PHE		27/11/19			27/11/19

SHAFT TYPE / SERIAL NO. SHAFT

SHAFT NO	SHAFT TYPE
1XX	PHE
2XX	HVAC
3XX	ELECTRICAL
4XX	ELV

CUTOUT LEGEND:

	FLOOR CUTOUT
	ROOF CUTOUT

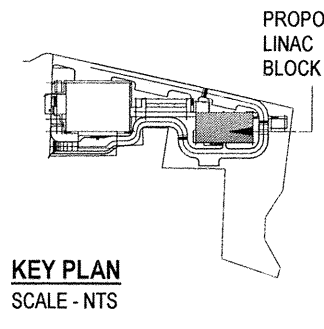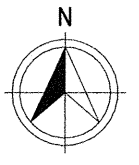

KEY PLAN
SCALE - NTS